





Elevation B 2 Car - Sheet List

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Sheet Name

Sheet Number

CONTRACTOR AND BUILDER SHALL REVIEW ENTIRE PLAN TO VERIFY CONFORMANCE WITH ALL CURRENT APPLICABLE CODES IN EFFECT AT TIME OF CONSTRUCTION. BY USING THESE DRAWINGS FOR CONSTRUCTION IT IS UNDERSTOOD THAT CONFORMANCE WITH ALL APPLICABLE CODES IS THE RESPONSIBILITY OF THE BUILDER AND CONTRACTOR.

Elevation B 2Car

1508 -

Front & Rear Elevations

Lot #:

Area Schedule (Elev B 2Car)

Area

595 SF

913 SF 1508 SF

73 SF

438 SF 511 SF

2019 SF

Name

Unheated

Under Roof

1st Floor 2nd Floor


Front Porch


Garage

Address:

Last Revision Date: 11-27-23



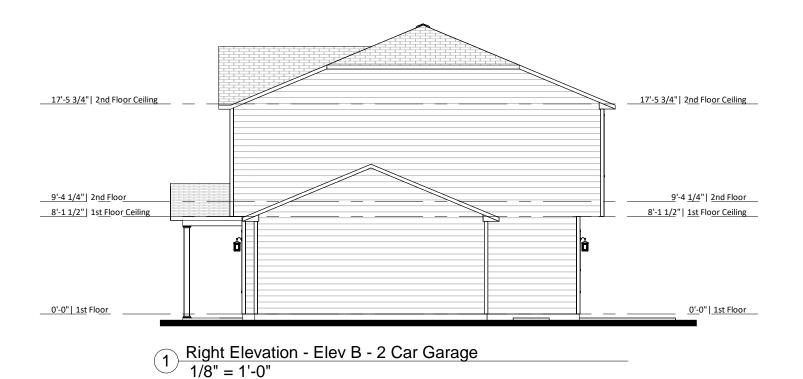

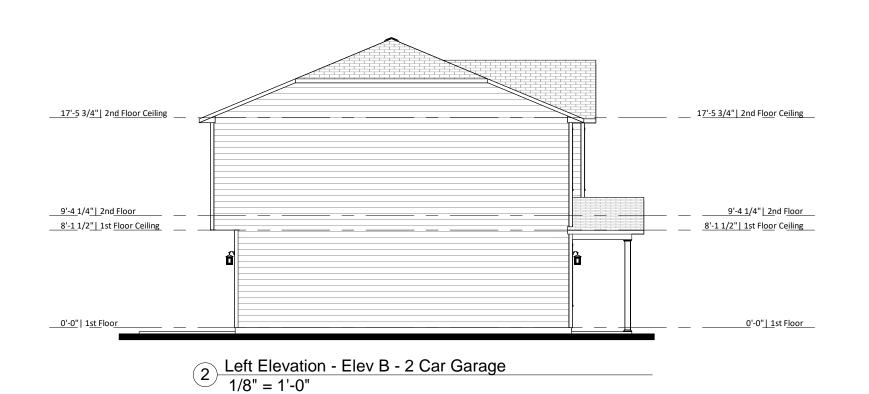


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Side Elevations

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TABLE R302.6 Dwell	TABLE R302.6 Dwelling/Garage Separation				
<u>Separation</u>	<u>Material</u>				
From the residence and attics	Not less than 1/2-inch gypsum board or equiva				
	applied to the garage side				
From all habitable rooms above the garage	Not less than 5/8 -inch Type X gypsum boa				
	or equivalent				
Structure(s) supporting floor-ceiling assemblies	Not less than 1/2-inch gypsum board				
used for separation required by this section	or equivalent				



1st Floor Plan - Elev B - 2 Car Garage 1/8" = 1'-0"

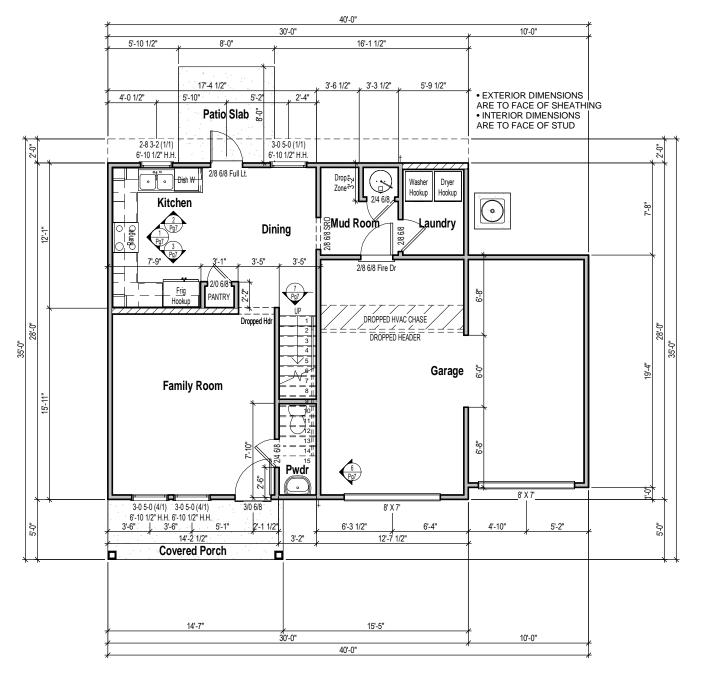


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1508 - Elevation B 2Car

1st Floor Plan

Last Revision Date: 11-27-23

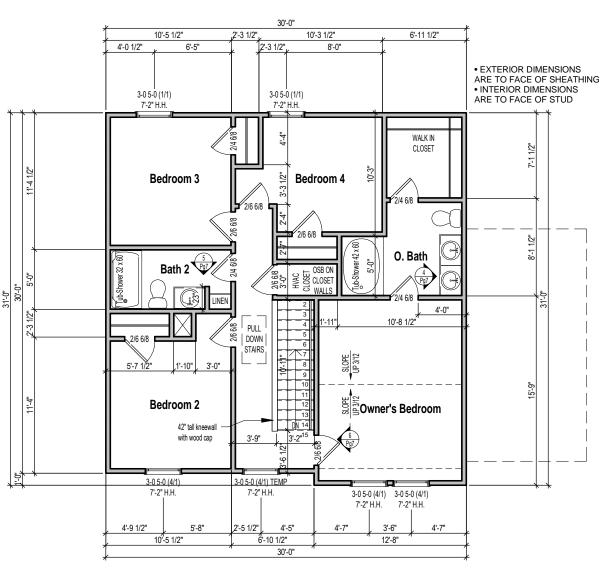

2nd Floor Plan - Elev B - 2 Car Garage
1/8" = 1'-0"



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2nd Floor Plan

1508 - Elevation B 2Car

Lot #:

Address:


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Area Schedule (Attic Elev B) Ventilation Required Area Max (sq.in.) Min (sq.in.) Upper (sq.in.) Lower Ventilation (sq.in.) Total Ventilation (sq.in.) Ridge Venti Vents (vents (sq.in.) Roof Vents (vents (sq.in.) Ventilation (sq.in.) Vents (sq.in.) Ven Main Roof

- CALCS BASED ON THE FOLLOWING VALUES

 Ridge Vents = 15 in² of net free area per linear foot

 Roof Vents = 50 in² of net free area per unit
- Soffit Vents = 6 in² of net free area per square foot

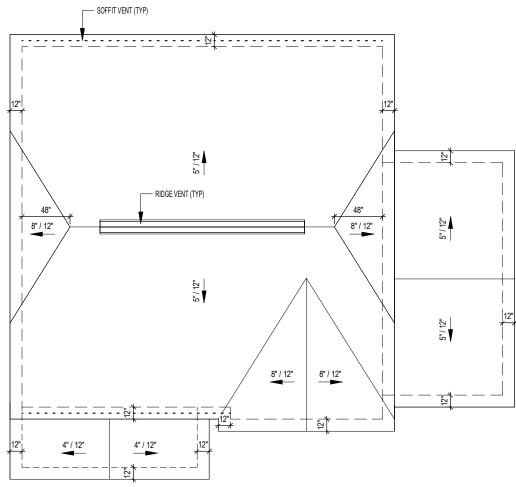

Roof Plan - Elev B - 2 Car Garage 1/8" = 1'-0"




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Elevation B 2Car

1508 -

Roof Plan

Last Revision Date: 11-27-23

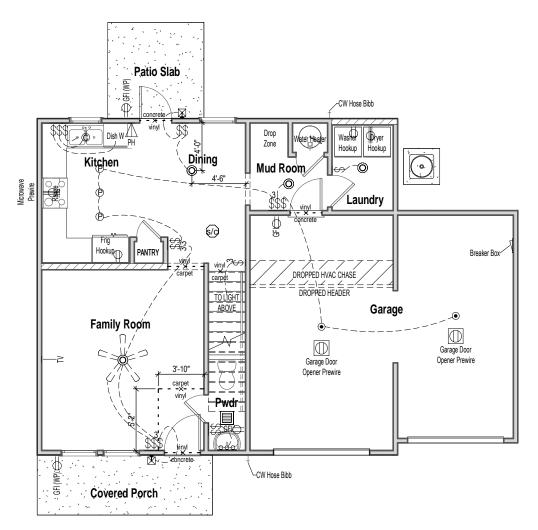

1 1st Floor Electrical - Elev B - 2 Car Garage 1/8" = 1'-0"

Bedroom 3 Bedroom 4 CLOSET Carpet \$ Vinyl	
Bath 2 S PULL DOWN STAIRS STAIRS O. Bath O. Bath	
Bedroom 2	


2 2nd Floor Electrical - Elev B - 2 Car Garage 1/8" = 1'-0"

ELECTRICAL LEGEND									
WALL MOUNTED FIXTURES					CEILING MOUNTED FIXTURES				
	OUTLET - 110V	OL OL	UTLET - TV	\bigcirc	WALL LIGHT	GARAGE DOOR Garage Door Opener Prewire GARAGE DOOR OPENER PREWIRE	S SMOKE DETECTOR		
	OUTLET - 110V GROUND FAULT INTERRUPTER	PH OI	UTLET - PHONE	000	18" LIGHT BAR	FLUSH MOUNT	S/C SMOKE DETECTOR/CO2		
GFI (WP)	OUTLET - 110V GROUND FAULT INTERRUPTER WATER PROOF	\$ sv	WITCH - SINGLE POLE		COACH LIGHT - FRONT DOOR	© RECESSED CAN P RECESSED CANLESS	BATHROOM EXHAUST FAN		
	OUTLET - 220V	\$\frac{\$^3}{2} sv	WITCH - 3 WAY		COACH LIGHT - REAR DOOR	C I FLUSH MOUNT W-FAN PREWIRE	FLUSH MOUNT		
	FLUORESCENT 1'X4' 2 LAMPS	\$ sv	WITCH - 4 WAY	•	KEYLESS	W-FAN PREWIRE	W-FAN		


Outlets shown on the electrical layout are in addition to the outlets that shall be provided in accordance with International Residential Code Sections E3901.2 through E3901.11.

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POP HOMES
MAKING LIFE BETTER

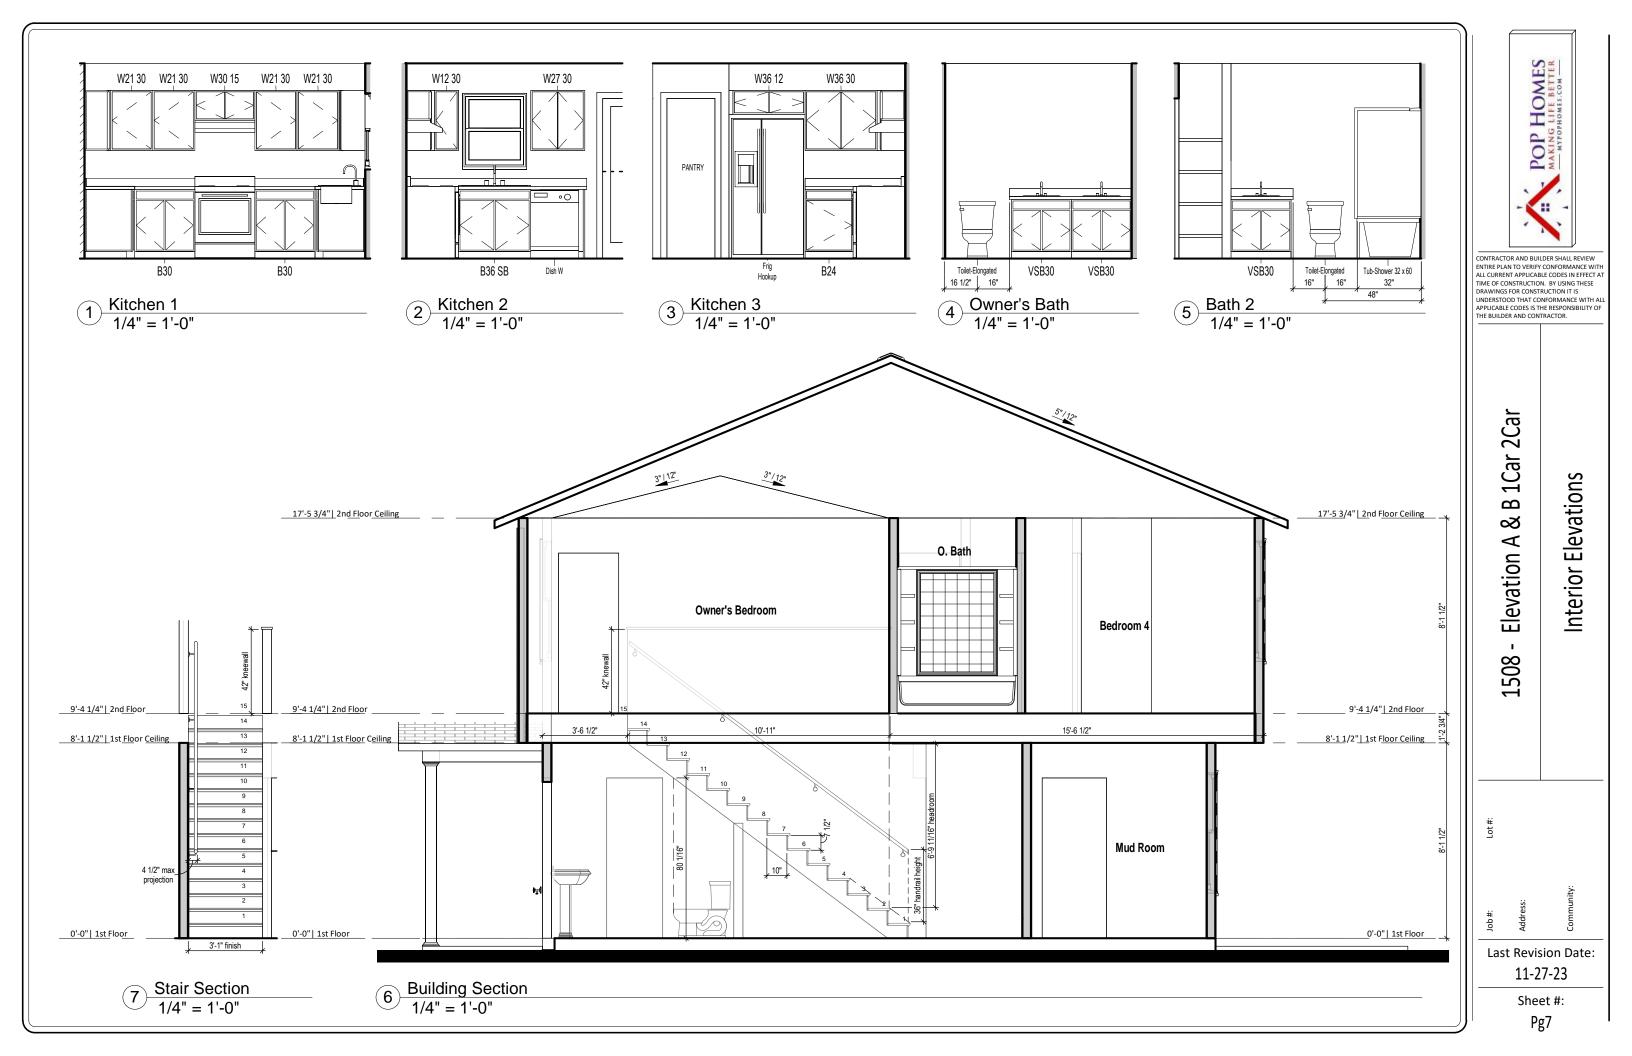

REFER TO STRUCTURAL DRAWINGS FOR ALL FOUNDATION DIMENSIONS

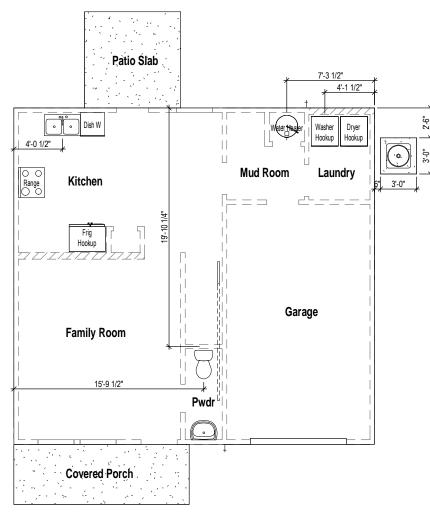

Slab Penetrations
1/8" = 1'-0"



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B 1Car 2Car

Slab Penetrations

Elevation A &

1508

Lot #:

Address:

Last Revision Date: 11-27-23

Sheet #:

Pg8