

| Elevation B - Sheet List |                            |
|--------------------------|----------------------------|
| Sheet Number             | Sheet Name                 |
| ElevB-Pg1                | Front & Rear Elevations    |
| ElevB-Pg2                | Side Elevations            |
| ElevB-Pg3                | 1st Floor Plan             |
| ElevB-Pg4                | 2nd Floor Plan             |
| ElevB-Pg5                | Roof Plan                  |
| ElevB-Pg6                | Electrical & Flooring Plan |
| Pg7                      | Interior Elevations        |
| Pg8                      | Slab Penetrations          |




① Front Elevation - Elev B  
1/8" = 1'-0"



② Rear Elevation - Elev B  
1/8" = 1'-0"

| Area Schedule (Elev B) |                |
|------------------------|----------------|
| Name                   | Area           |
| <b>Heated</b>          |                |
| 1st Floor              | 1035 SF        |
| 2nd Floor              | 1467 SF        |
|                        | 2502 SF        |
| <b>Unheated</b>        |                |
| Front Porch            | 36 SF          |
| Garage                 | 392 SF         |
|                        | 428 SF         |
| <b>Under Roof</b>      | <b>2930 SF</b> |

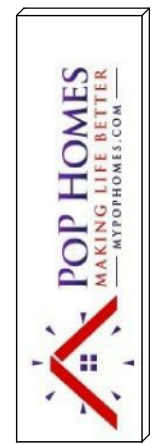

CONTRACTOR AND BUILDER SHALL REVIEW ENTIRE PLAN TO VERIFY CONFORMANCE WITH ALL CURRENT APPLICABLE CODES IN EFFECT AT TIME OF CONSTRUCTION. BY USING THESE DRAWINGS FOR CONSTRUCTION IT IS UNDERSTOOD THAT CONFORMANCE WITH ALL APPLICABLE CODES IS THE RESPONSIBILITY OF THE BUILDER AND CONTRACTOR.

2502 RH - Elevation B

Front & Rear Elevations

Lot #:

Job #:

Address:

Community:


Last Revision Date:

8-25-21


Sheet #:  
ElevB-Pg1



CONTRACTOR AND BUILDER SHALL REVIEW ENTIRE PLAN TO VERIFY CONFORMANCE WITH ALL CURRENT APPLICABLE CODES IN EFFECT AT TIME OF CONSTRUCTION. BY USING THESE DRAWINGS FOR CONSTRUCTION IT IS UNDERSTOOD THAT CONFORMANCE WITH ALL APPLICABLE CODES IS THE RESPONSIBILITY OF THE BUILDER AND CONTRACTOR.

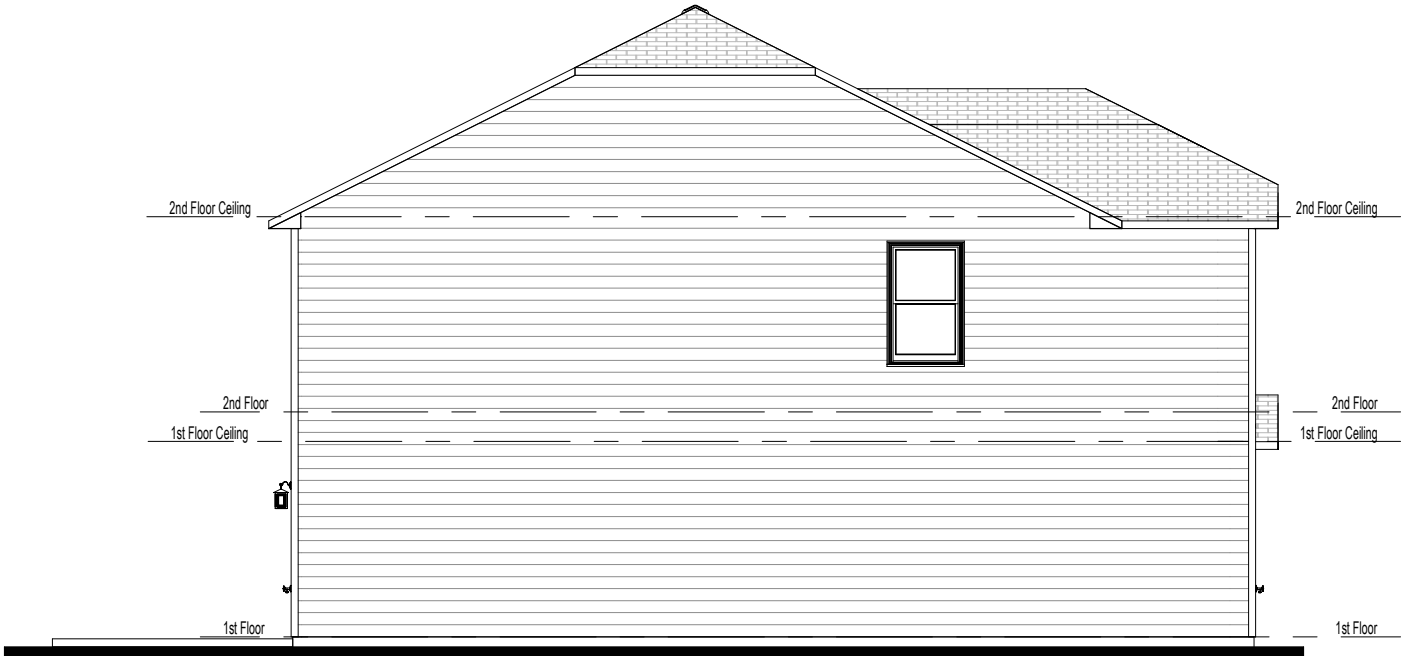

① Left Elevation - Elev B  
1/8" = 1'-0"

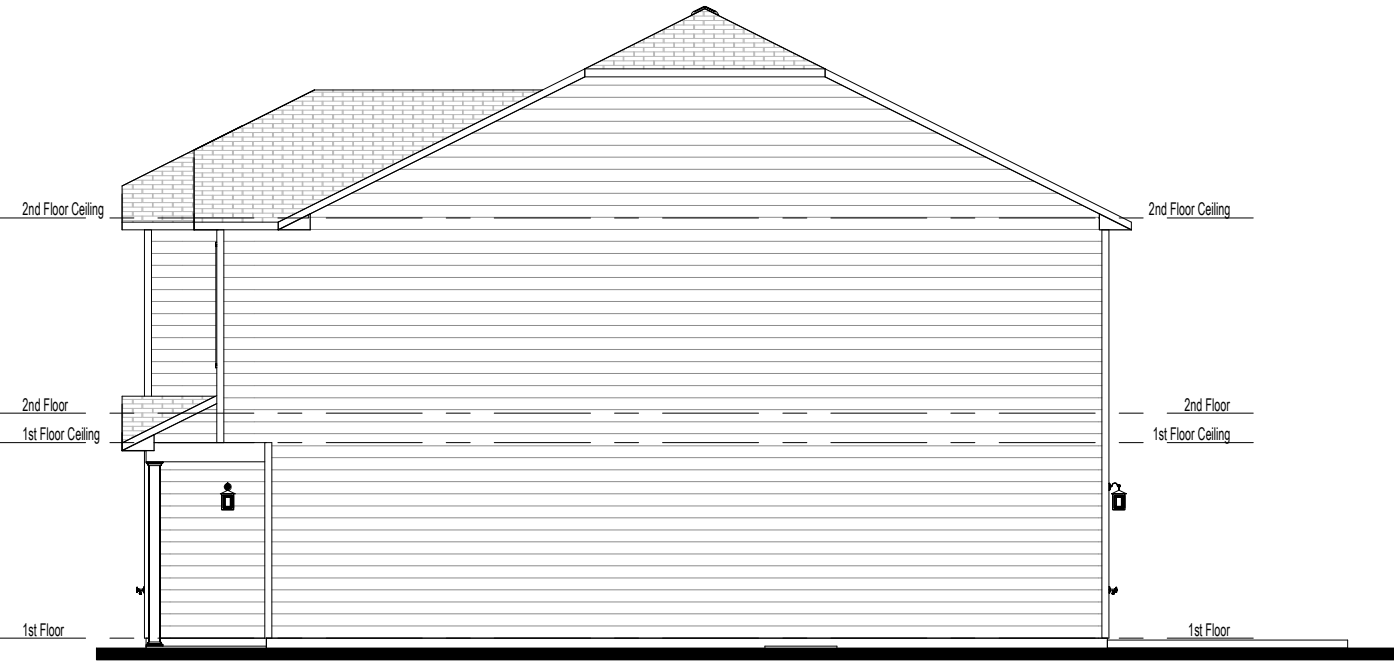

② Right Elevation - Elev B  
1/8" = 1'-0"

2502 RH - Elevation B

Side Elevations

Lot #:

Job #:

Address:

Community:

Last Revision Date:


8-25-21

Sheet #:

ElevB-Pg2

| TABLE R302.6 Dwelling/Garage Separation   |  |
|---|--|
| Separation  | Material   |
| From the residence and attics   | Not less than 1/2-inch gypsum board or equivalent applied to the garage side |
| From all habitable rooms above the garage   | Not less than 5/8-inch Type X gypsum board or equivalent                     |
| Structure(s) supporting floor-ceiling assemblies used for separation required by this section | Not less than 1/2-inch gypsum board or equivalent                            |

Wall Stud Size  
 — = 2x4  
 // = 2x6

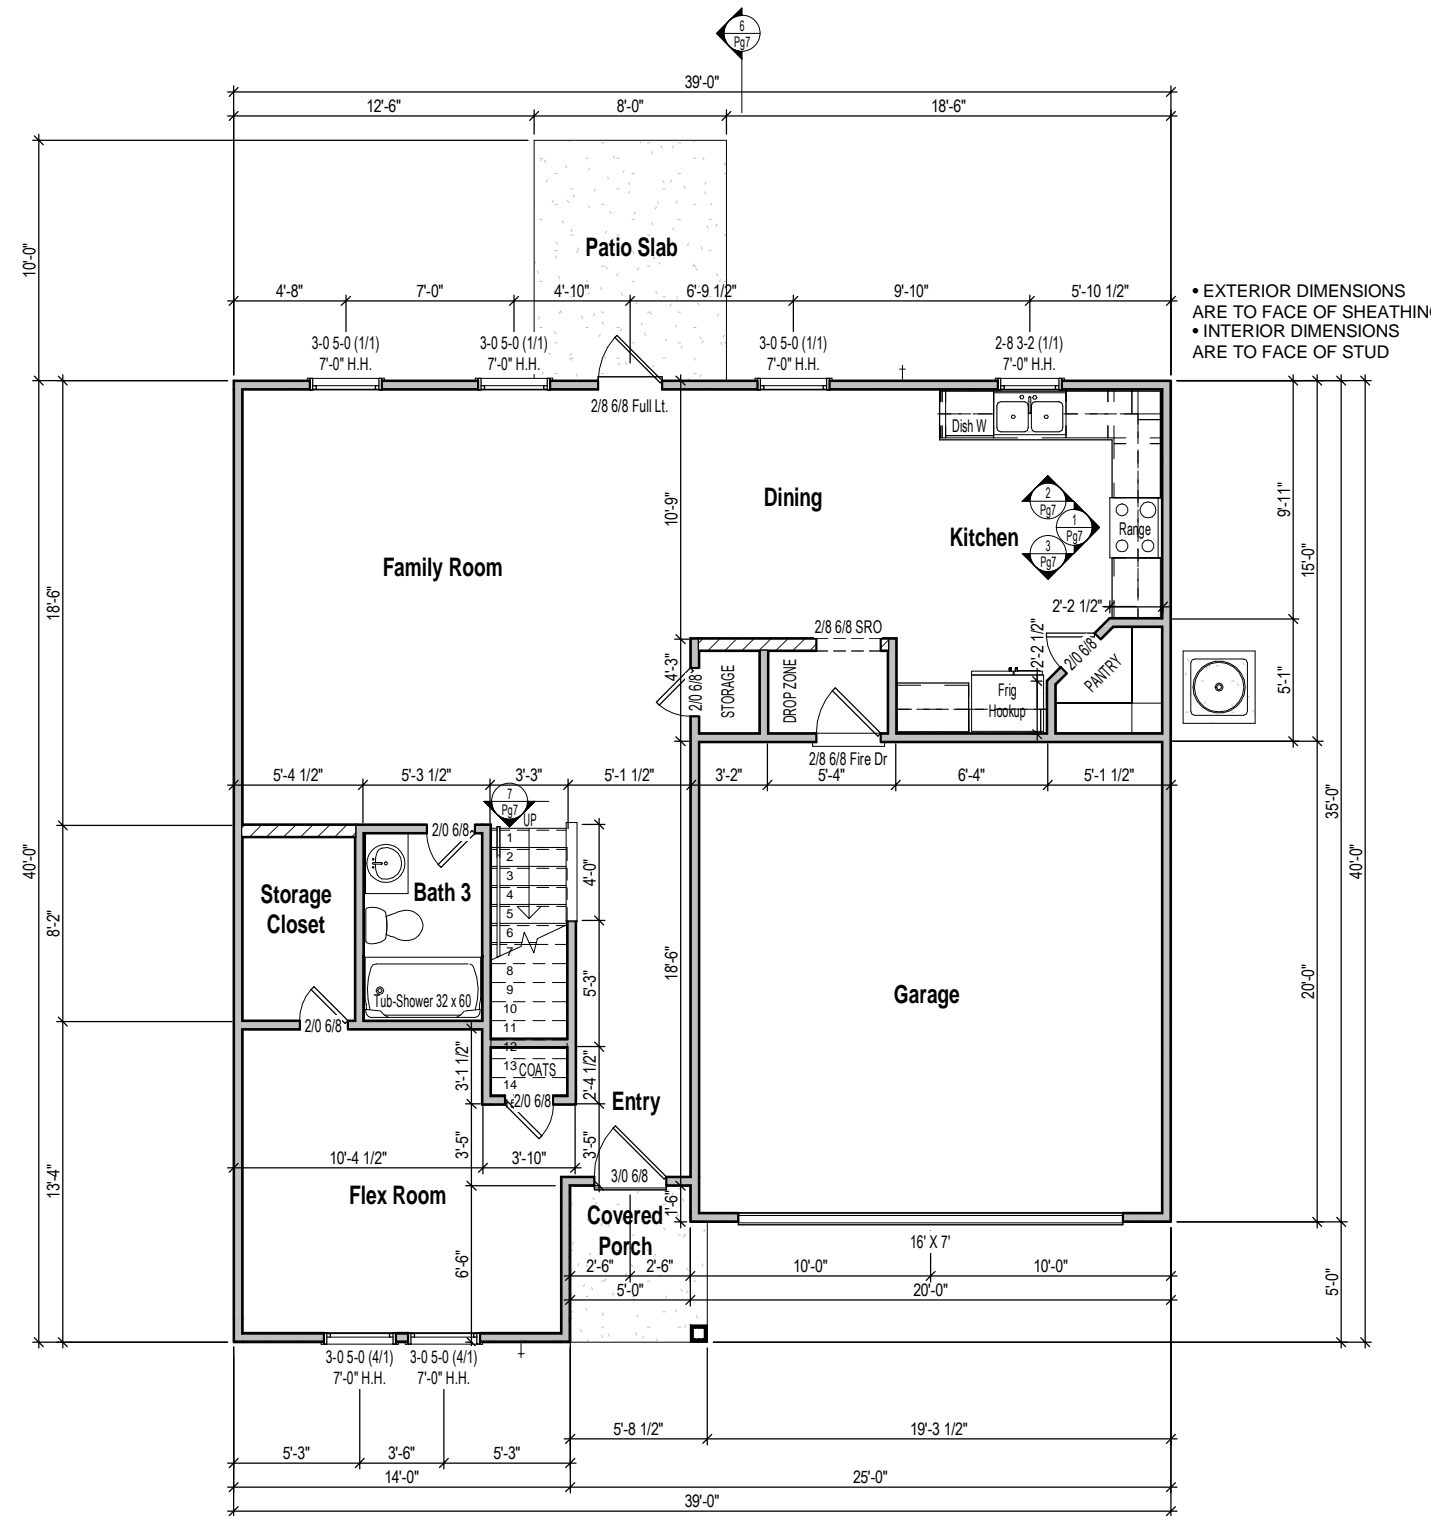

1 1st Floor Plan - Elev B  
 1/8" = 1'-0"



CONTRACTOR AND BUILDER SHALL REVIEW ENTIRE PLAN TO VERIFY CONFORMANCE WITH ALL CURRENT APPLICABLE CODES IN EFFECT AT TIME OF CONSTRUCTION. BY USING THESE DRAWINGS FOR CONSTRUCTION IT IS UNDERSTOOD THAT CONFORMANCE WITH ALL APPLICABLE CODES IS THE RESPONSIBILITY OF THE BUILDER AND CONTRACTOR.

2502 RH - Elevation B

1st Floor Plan

Lot #:

Job #:


Address:

Community:


Last Revision Date:  
 8-25-21

Sheet #:  
 ElevB-Pg3

Wall Stud Size  
 — = 2x4  
 // = 2x6

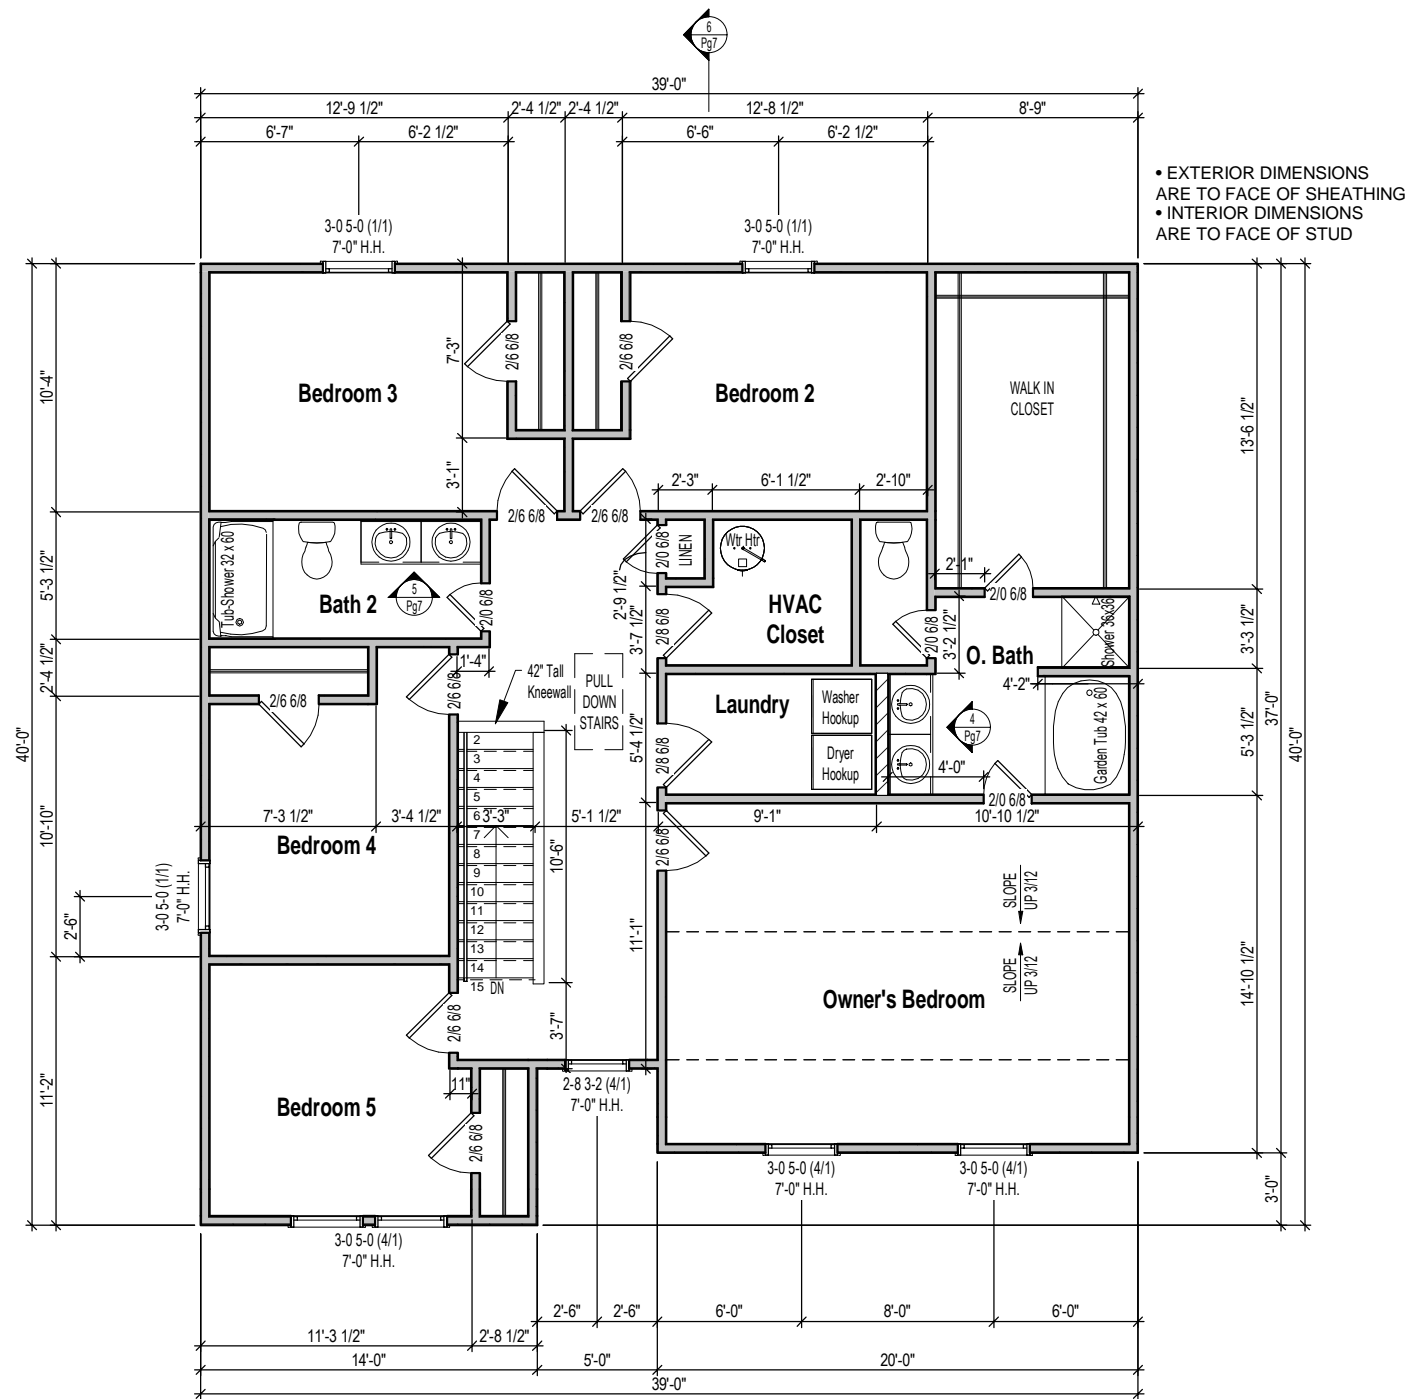

1 2nd Floor Plan - Elev B  
 1/8" = 1'-0"

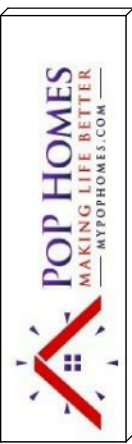

CONTRACTOR AND BUILDER SHALL REVIEW ENTIRE PLAN TO VERIFY CONFORMANCE WITH ALL CURRENT APPLICABLE CODES IN EFFECT AT TIME OF CONSTRUCTION. BY USING THESE DRAWINGS FOR CONSTRUCTION IT IS UNDERSTOOD THAT CONFORMANCE WITH ALL APPLICABLE CODES IS THE RESPONSIBILITY OF THE BUILDER AND CONTRACTOR.

2502 RH - Elevation B

2nd Floor Plan

Lot #:

Job #:

Address:

Community:


Last Revision Date:  
 8-25-21

Sheet #:  
 ElevB-Pg4

### Area Schedule (Attic Elev B)

| Name      | Area    | Ventilation Required (sq.in.) | Max Upper (sq.in.) | Min Upper (sq.in.) | Upper Ventilation (sq.in.) | Lower Ventilation (sq.in.) | Total Ventilation (sq.in.) | Ridge Vent (ln.ft.) | Roof Vents (ea) | Soffit Vents (sq.ft.) |
|-----------|---------|-------------------------------|--------------------|--------------------|----------------------------|----------------------------|----------------------------|---------------------|-----------------|-----------------------|
| Main Roof | 1468 SF | 704                           | 564                | 352                | 405                        | 366                        | 771                        | 27                  | 0               | 61                    |

- CALCS BASED ON THE FOLLOWING VALUES**
- Ridge Vents = 15 in<sup>2</sup> of net free area per linear foot
  - Roof Vents = 50 in<sup>2</sup> of net free area per unit
  - Soffit Vents = 6 in<sup>2</sup> of net free area per square foot

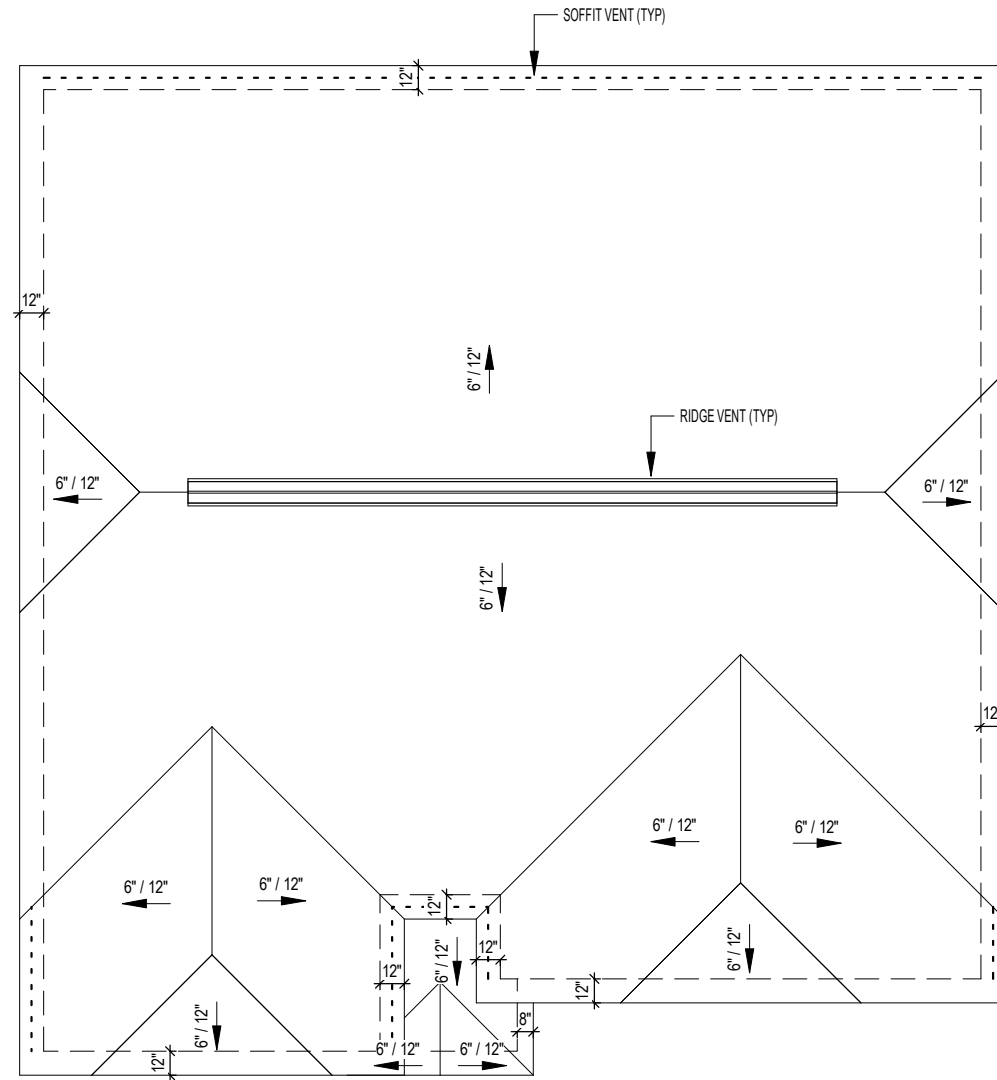

1 Roof Plan - Elev B  
1/8" = 1'-0"



CONTRACTOR AND BUILDER SHALL REVIEW ENTIRE PLAN TO VERIFY CONFORMANCE WITH ALL CURRENT APPLICABLE CODES IN EFFECT AT TIME OF CONSTRUCTION. BY USING THESE DRAWINGS FOR CONSTRUCTION IT IS UNDERSTOOD THAT CONFORMANCE WITH ALL APPLICABLE CODES IS THE RESPONSIBILITY OF THE BUILDER AND CONTRACTOR.

2502 RH - Elevation B

Roof Plan

Lot #:

Job #:

Address:


Community:

Last Revision Date:  
8-25-21


Sheet #:  
ElevB-Pg5



CONTRACTOR AND BUILDER SHALL REVIEW ENTIRE PLAN TO VERIFY CONFORMANCE WITH ALL CURRENT APPLICABLE CODES IN EFFECT AT TIME OF CONSTRUCTION. BY USING THESE DRAWINGS FOR CONSTRUCTION IT IS UNDERSTOOD THAT CONFORMANCE WITH ALL APPLICABLE CODES IS THE RESPONSIBILITY OF THE BUILDER AND CONTRACTOR.

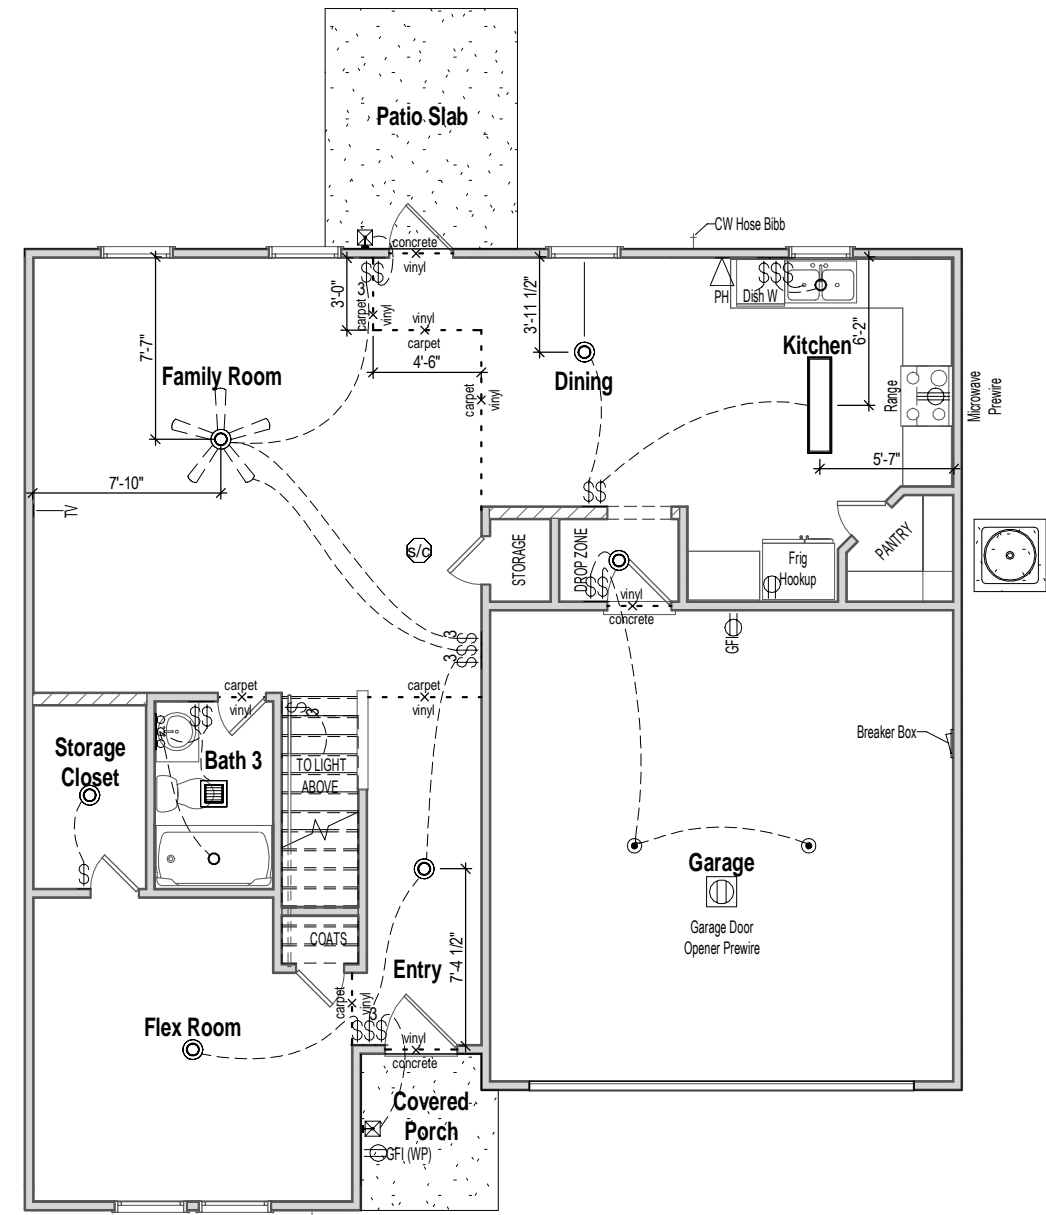

1 1st Floor Electrical - Elev B  
1/8" = 1'-0"

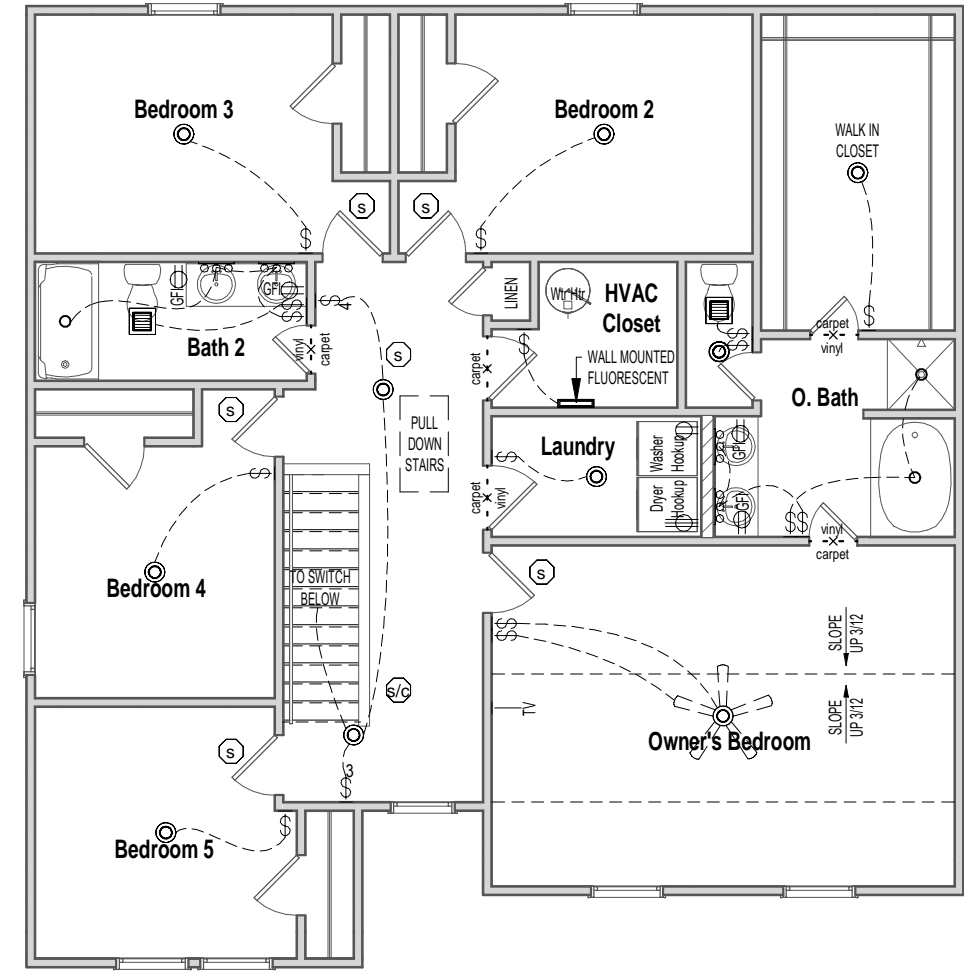

2 2nd Floor Electrical - Elev B  
1/8" = 1'-0"

| WALL MOUNTED FIXTURES |  |  | CEILING MOUNTED FIXTURES |  |                           |
|-----------------------|--|--|--------------------------|--|---------------------------|
|                       | OUTLET - 110V                                      |  | OUTLET - TV              |  | WALL LIGHT                |
|                       | OUTLET - 110V GROUND FAULT INTERRUPTER             |  | OUTLET - PHONE           |  | 18" LIGHT BAR             |
|                       | OUTLET - 110V GROUND FAULT INTERRUPTER WATER PROOF |  | SWITCH - SINGLE POLE     |  | COACH LIGHT - FRONT DOOR  |
|                       | OUTLET - 220V                                      |  | SWITCH - 3 WAY           |  | COACH LIGHT - REAR DOOR   |
|                       | FLUORESCENT 1'X4" 2 LAMPS                          |  | SWITCH - 4 WAY           |  | FLUSH MOUNT W-FAN PREWIRE |
|                       |  |  | KEYLESS                  |  | FLUSH MOUNT W-FAN         |

Outlets shown on the electrical layout are in addition to the outlets that shall be provided in accordance with International Residential Code Sections E3901.2 through E3901.11.

2502 RH - Elevation B

Electrical & Flooring Plan

Lot #:


Job #:

Address:


Community:

Last Revision Date:  
8-25-21


Sheet #:  
ElevB-Pg6

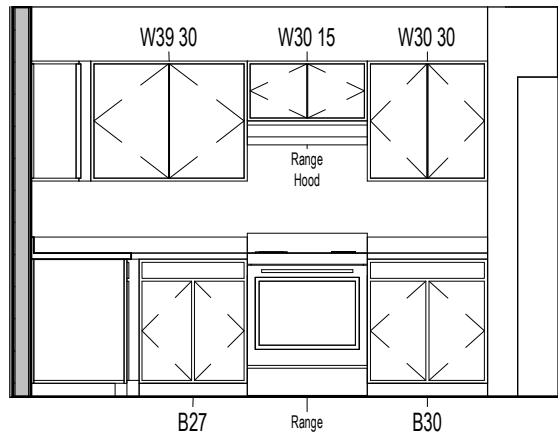


1 Kitchen 1  
1/4" = 1'-0"

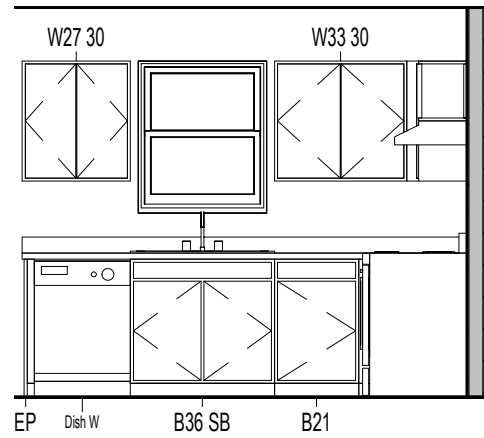


2 Kitchen 2  
1/4" = 1'-0"

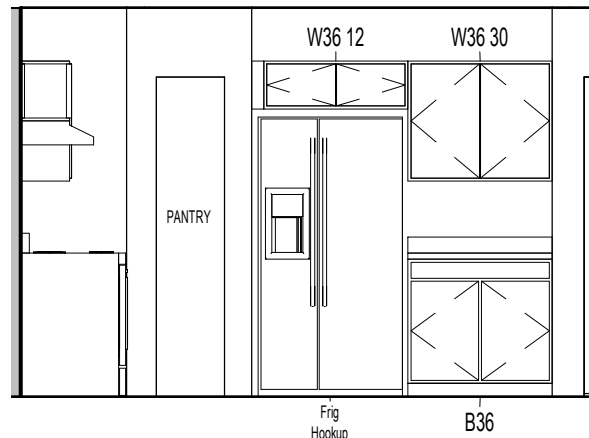


3 Kitchen 3  
1/4" = 1'-0"

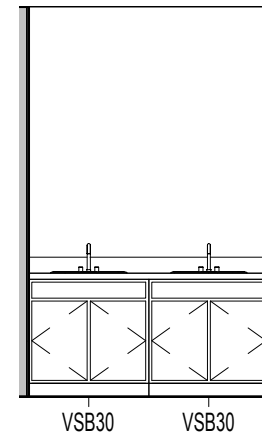


4 Owner's Bath  
1/4" = 1'-0"

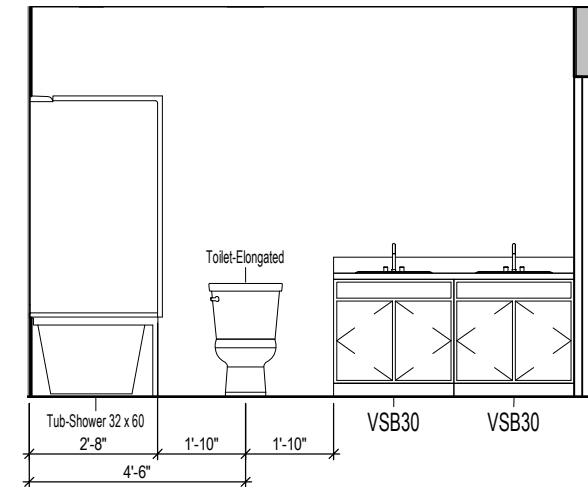


5 Bath 2  
1/4" = 1'-0"

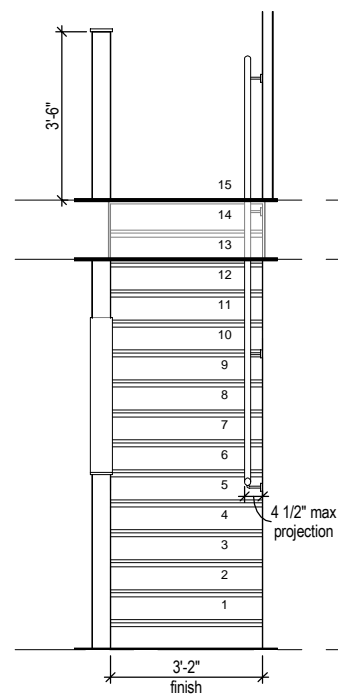

7 Stair Section  
1/4" = 1'-0"

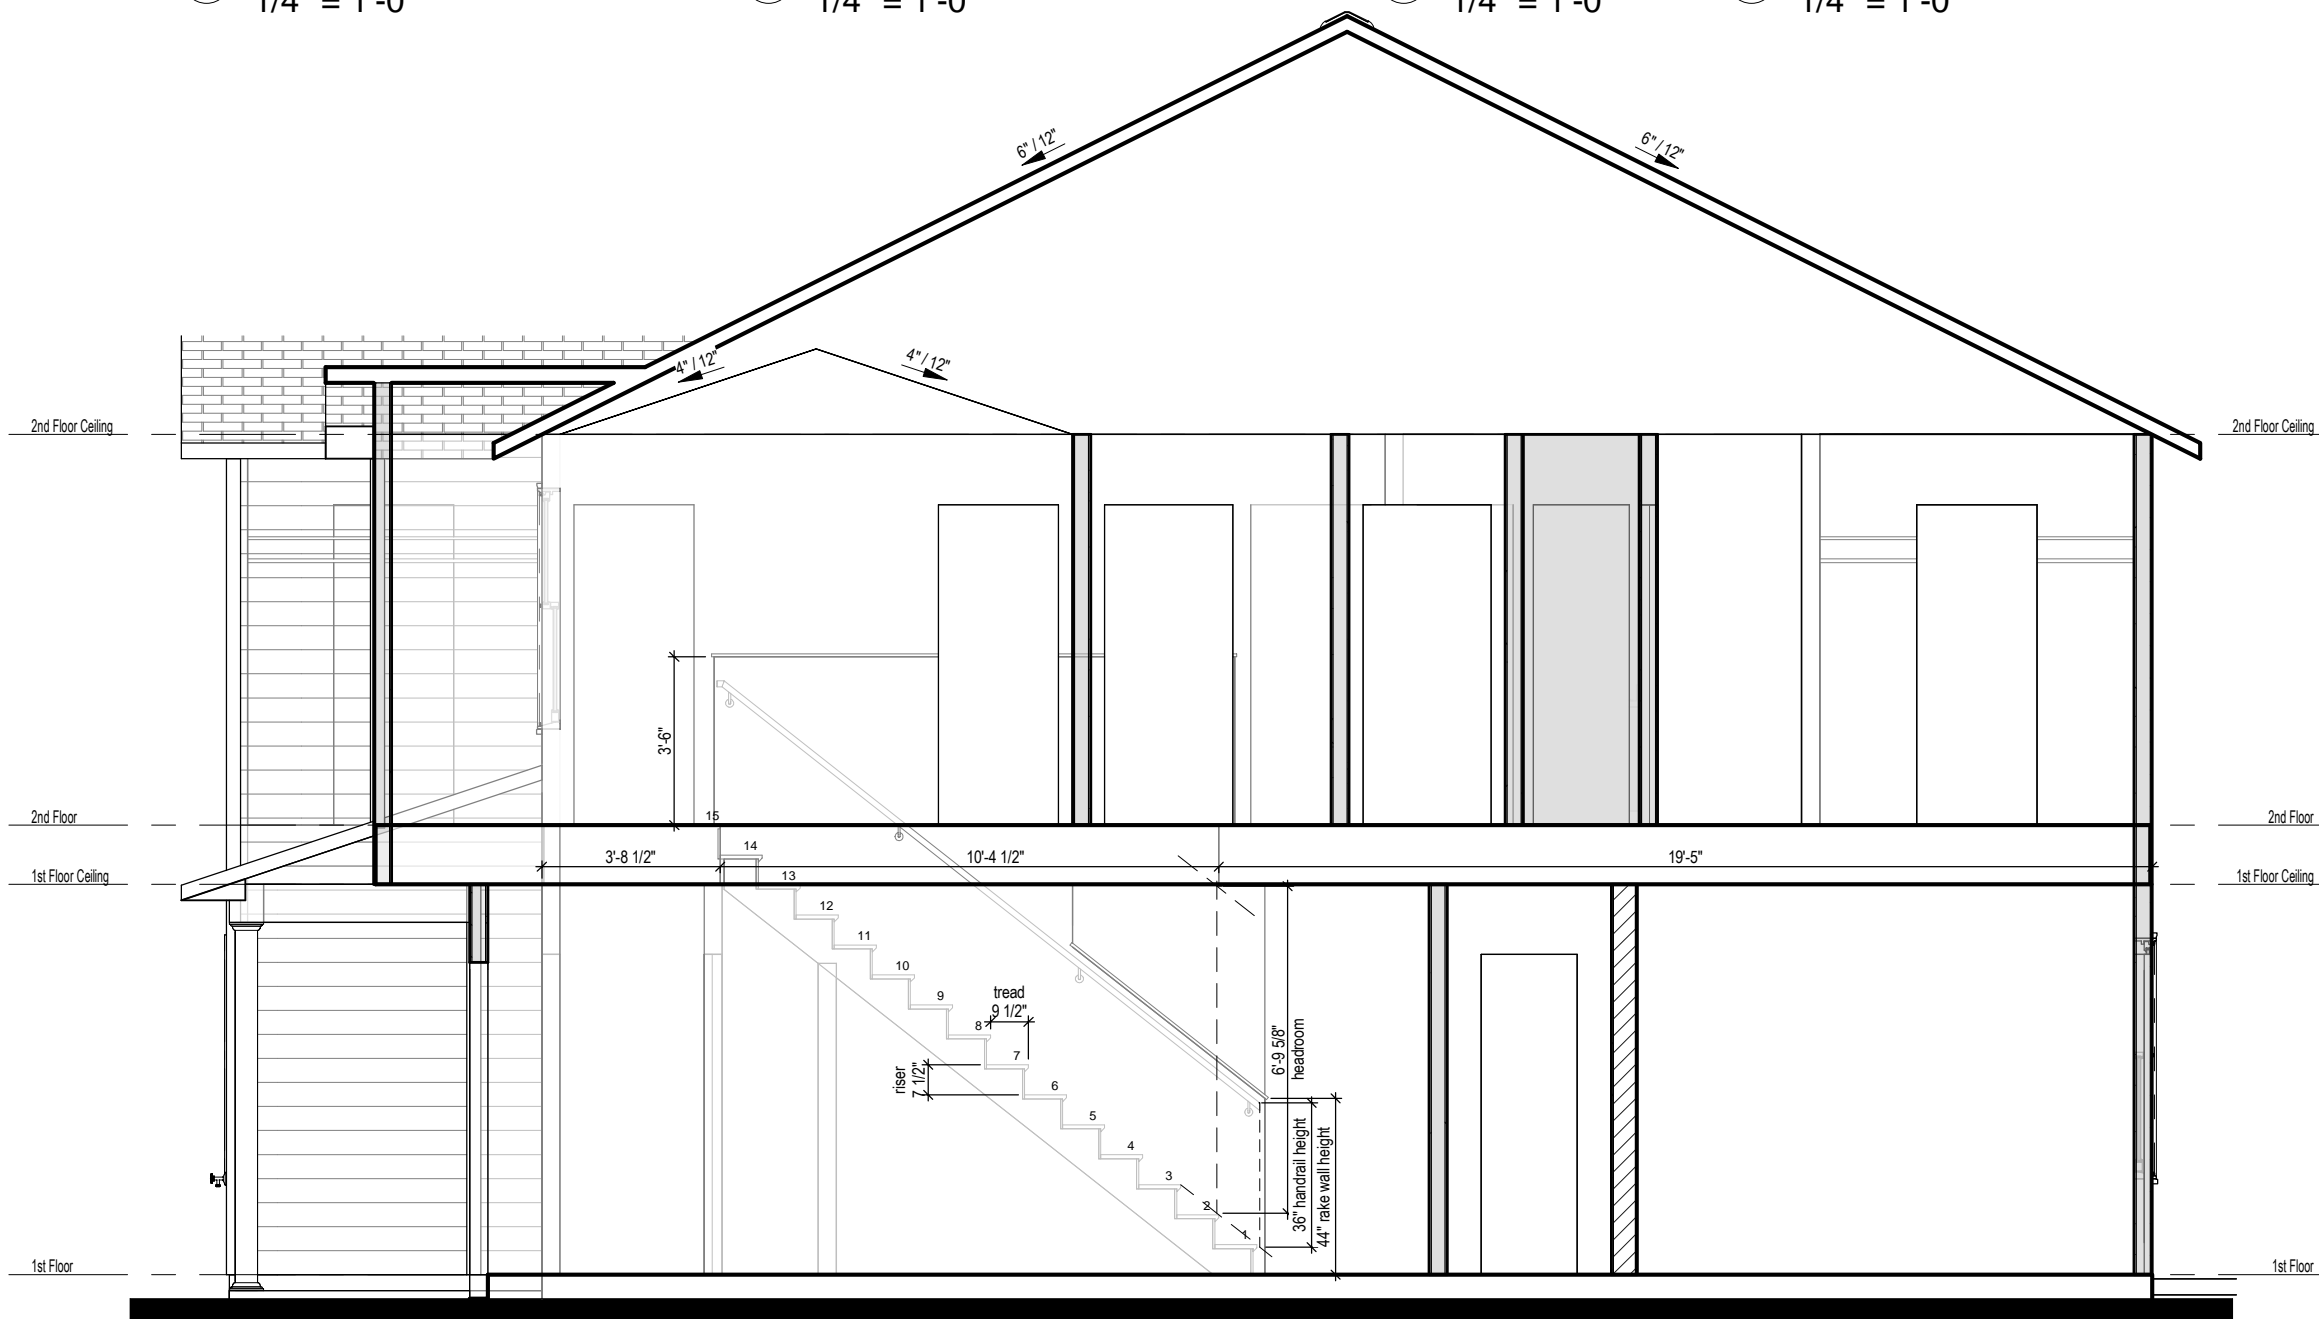

6 Building Section  
1/4" = 1'-0"

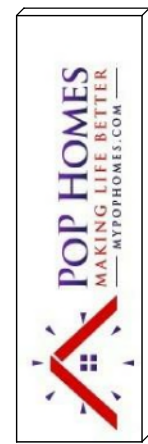


CONTRACTOR AND BUILDER SHALL REVIEW ENTIRE PLAN TO VERIFY CONFORMANCE WITH ALL CURRENT APPLICABLE CODES IN EFFECT AT TIME OF CONSTRUCTION. BY USING THESE DRAWINGS FOR CONSTRUCTION IT IS UNDERSTOOD THAT CONFORMANCE WITH ALL APPLICABLE CODES IS THE RESPONSIBILITY OF THE BUILDER AND CONTRACTOR.

2502 RH - Elevation A & B  
Interior Elevations

Lot #:  
Job #:  
Address:  
Community:

Last Revision Date:  
8-25-21

# REFER TO STRUCTURAL DRAWINGS FOR ALL FOUNDATION DIMENSIONS

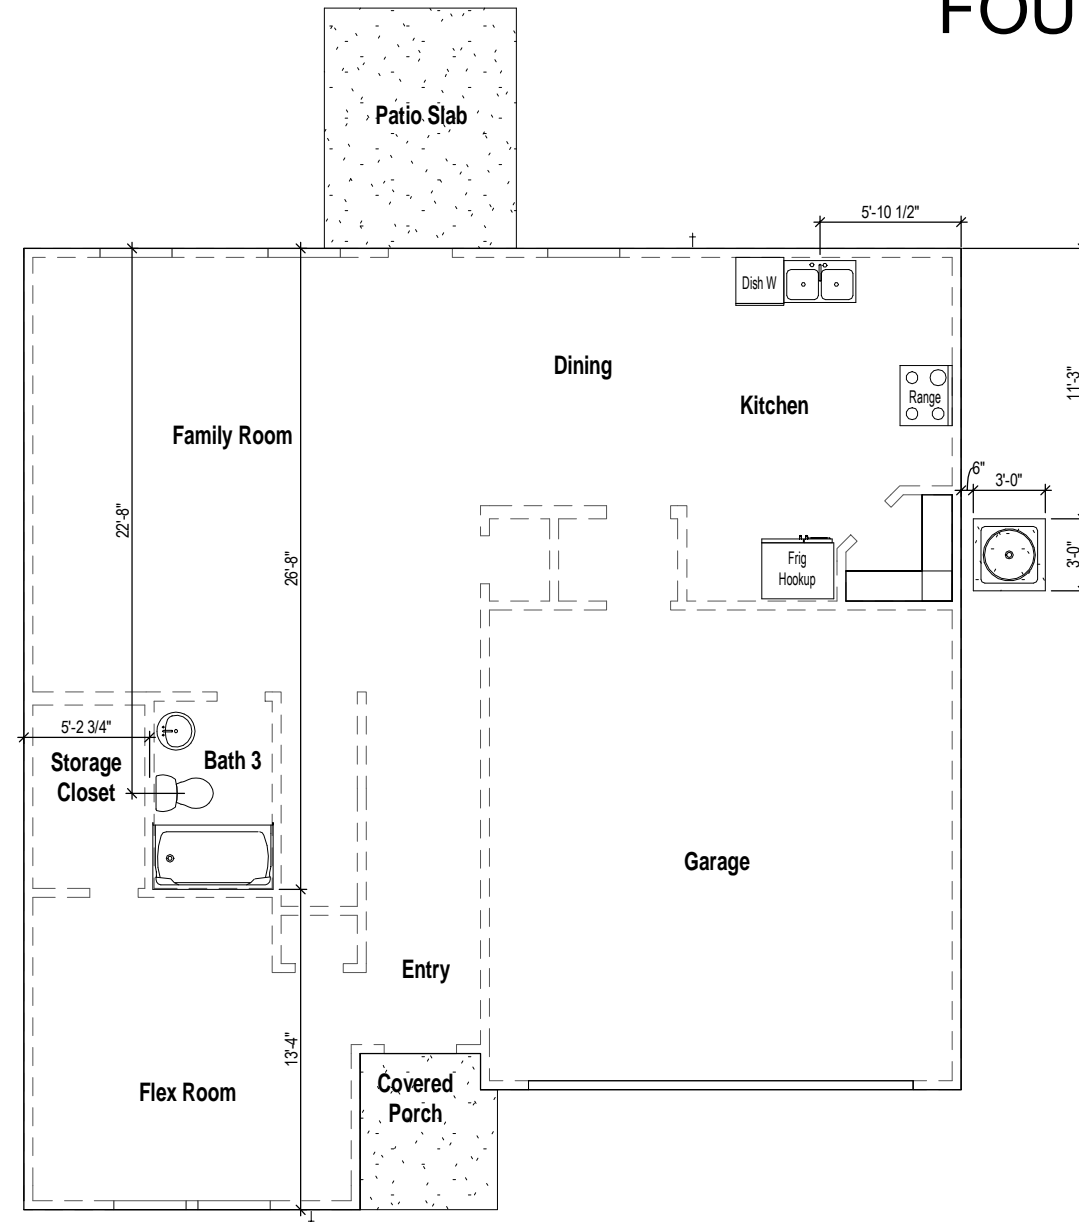

① Slab Penetrations  
1/8" = 1'-0"



CONTRACTOR AND BUILDER SHALL REVIEW ENTIRE PLAN TO VERIFY CONFORMANCE WITH ALL CURRENT APPLICABLE CODES IN EFFECT AT TIME OF CONSTRUCTION. BY USING THESE DRAWINGS FOR CONSTRUCTION IT IS UNDERSTOOD THAT CONFORMANCE WITH ALL APPLICABLE CODES IS THE RESPONSIBILITY OF THE BUILDER AND CONTRACTOR.

2502 RH - Elevation A & B

Slab Penetrations

Lot #:

Job #:

Address:

Community:

Last Revision Date:

8-25-21

Sheet #:

Pg8